



04 RIGHT ELEVATION  
SCALE: 1/8" = 1'-0"

PLAN NORTH

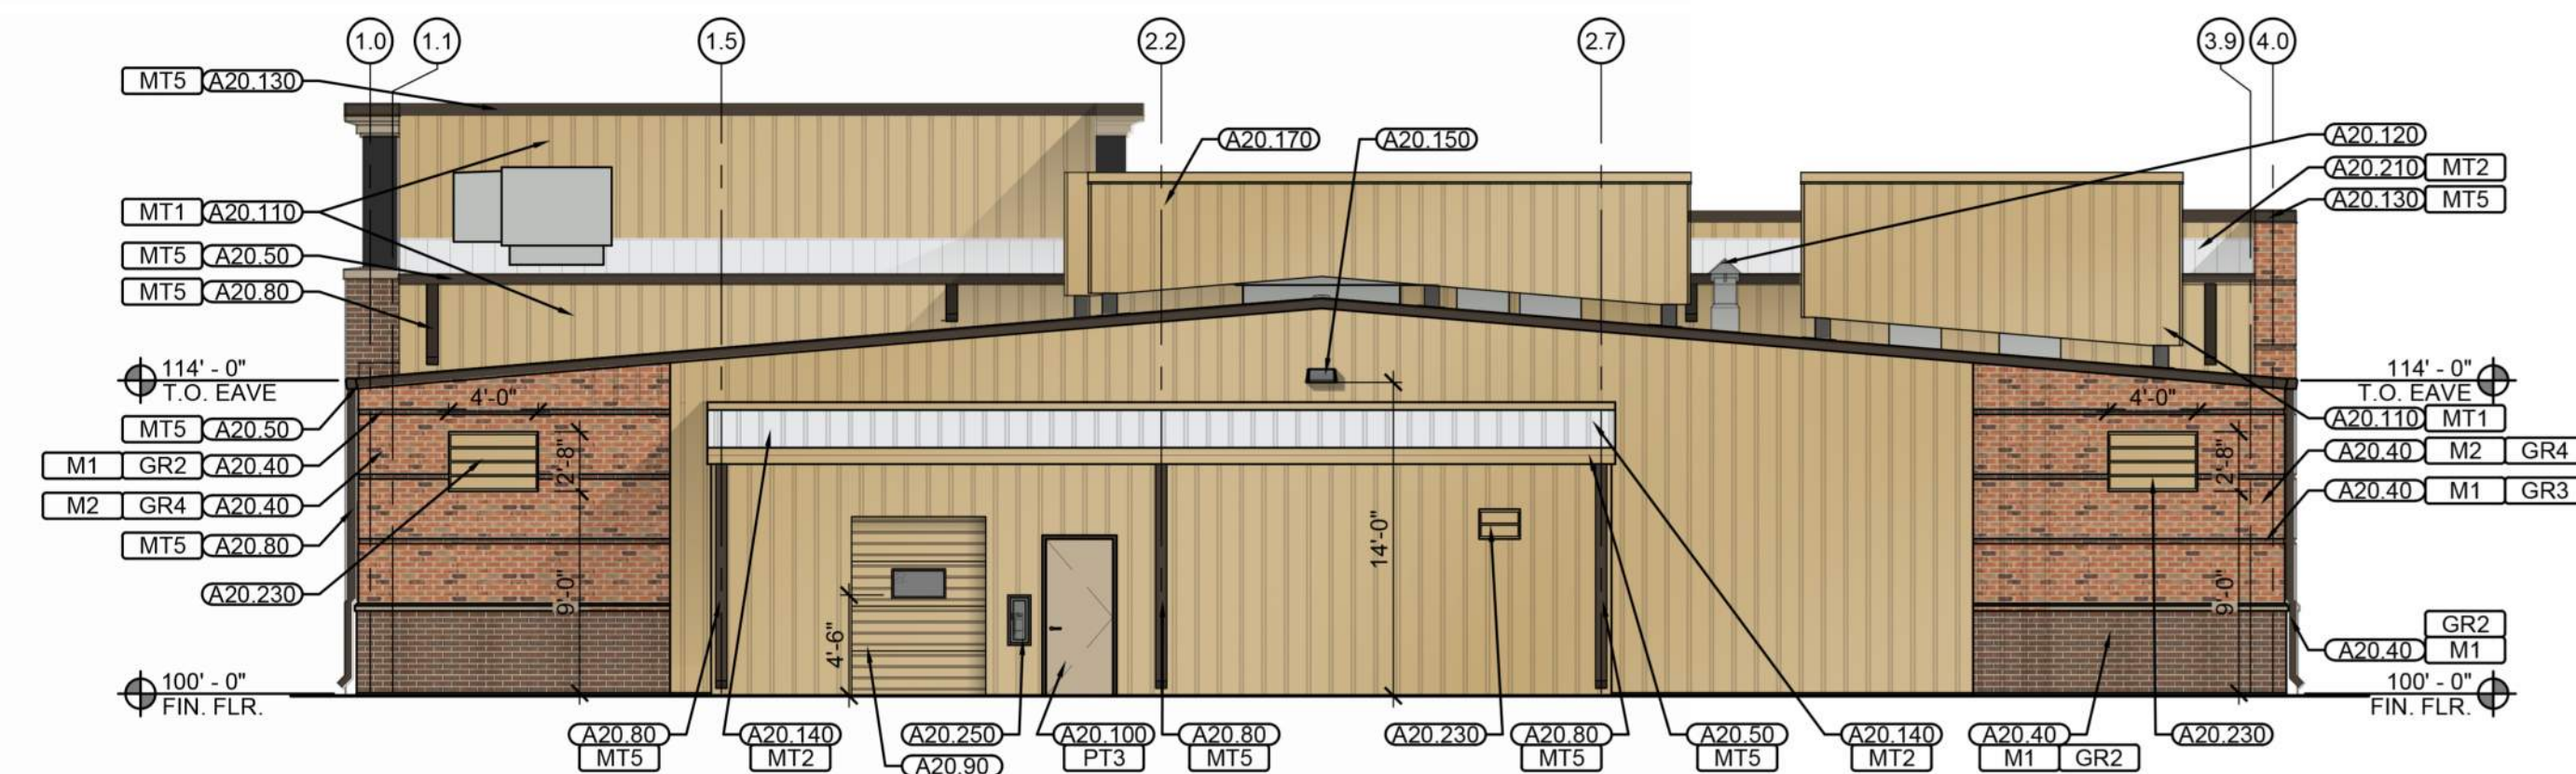


03 REAR ELEVATION  
SCALE: 1/8" = 1'-0"

PLAN WEST

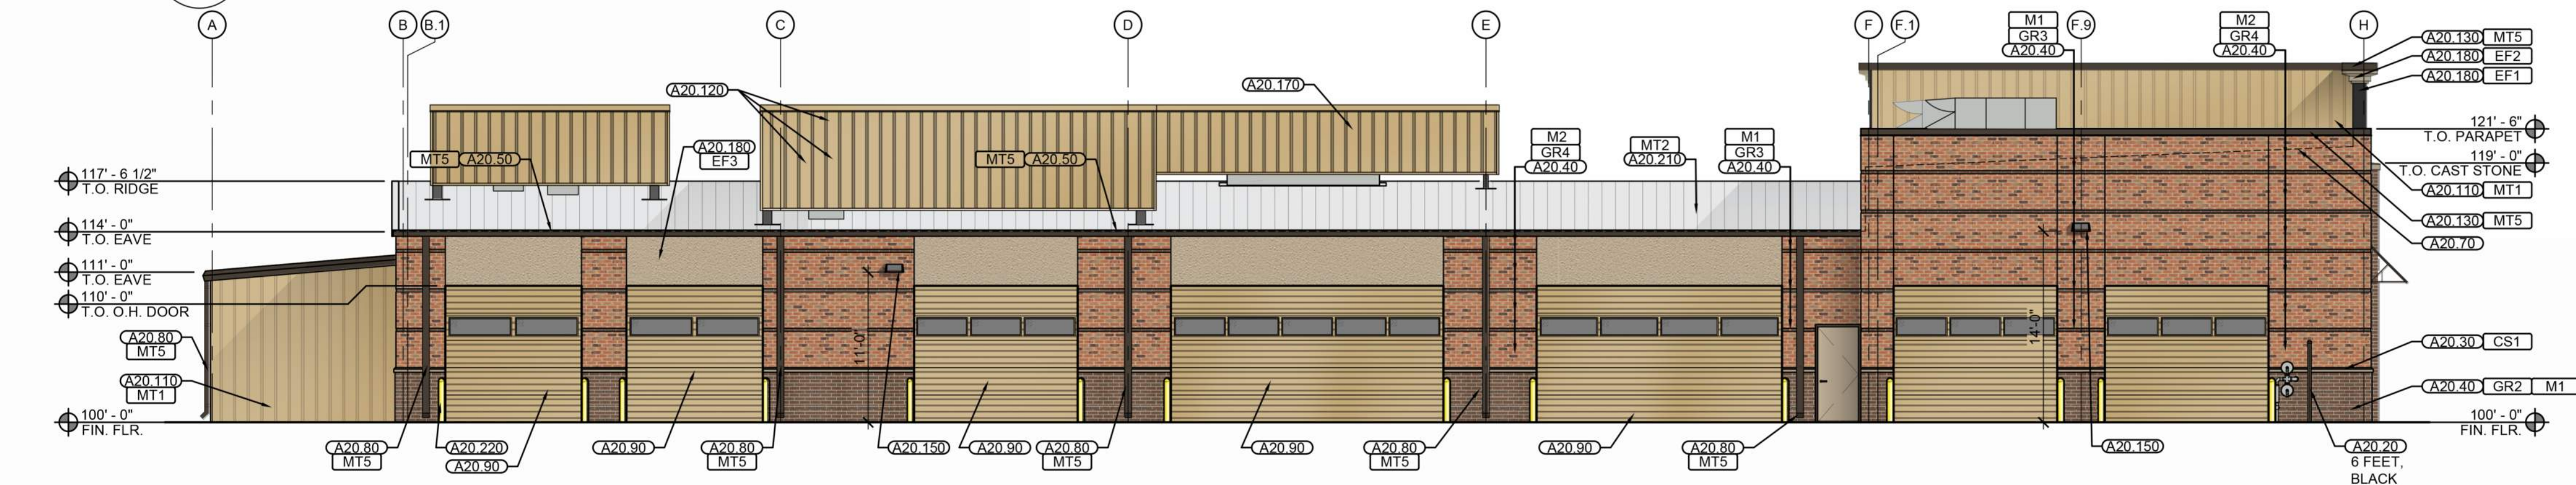

02 LEFT ELEVATION  
SCALE: 1/8" = 1'-0"

PLAN SOUTH

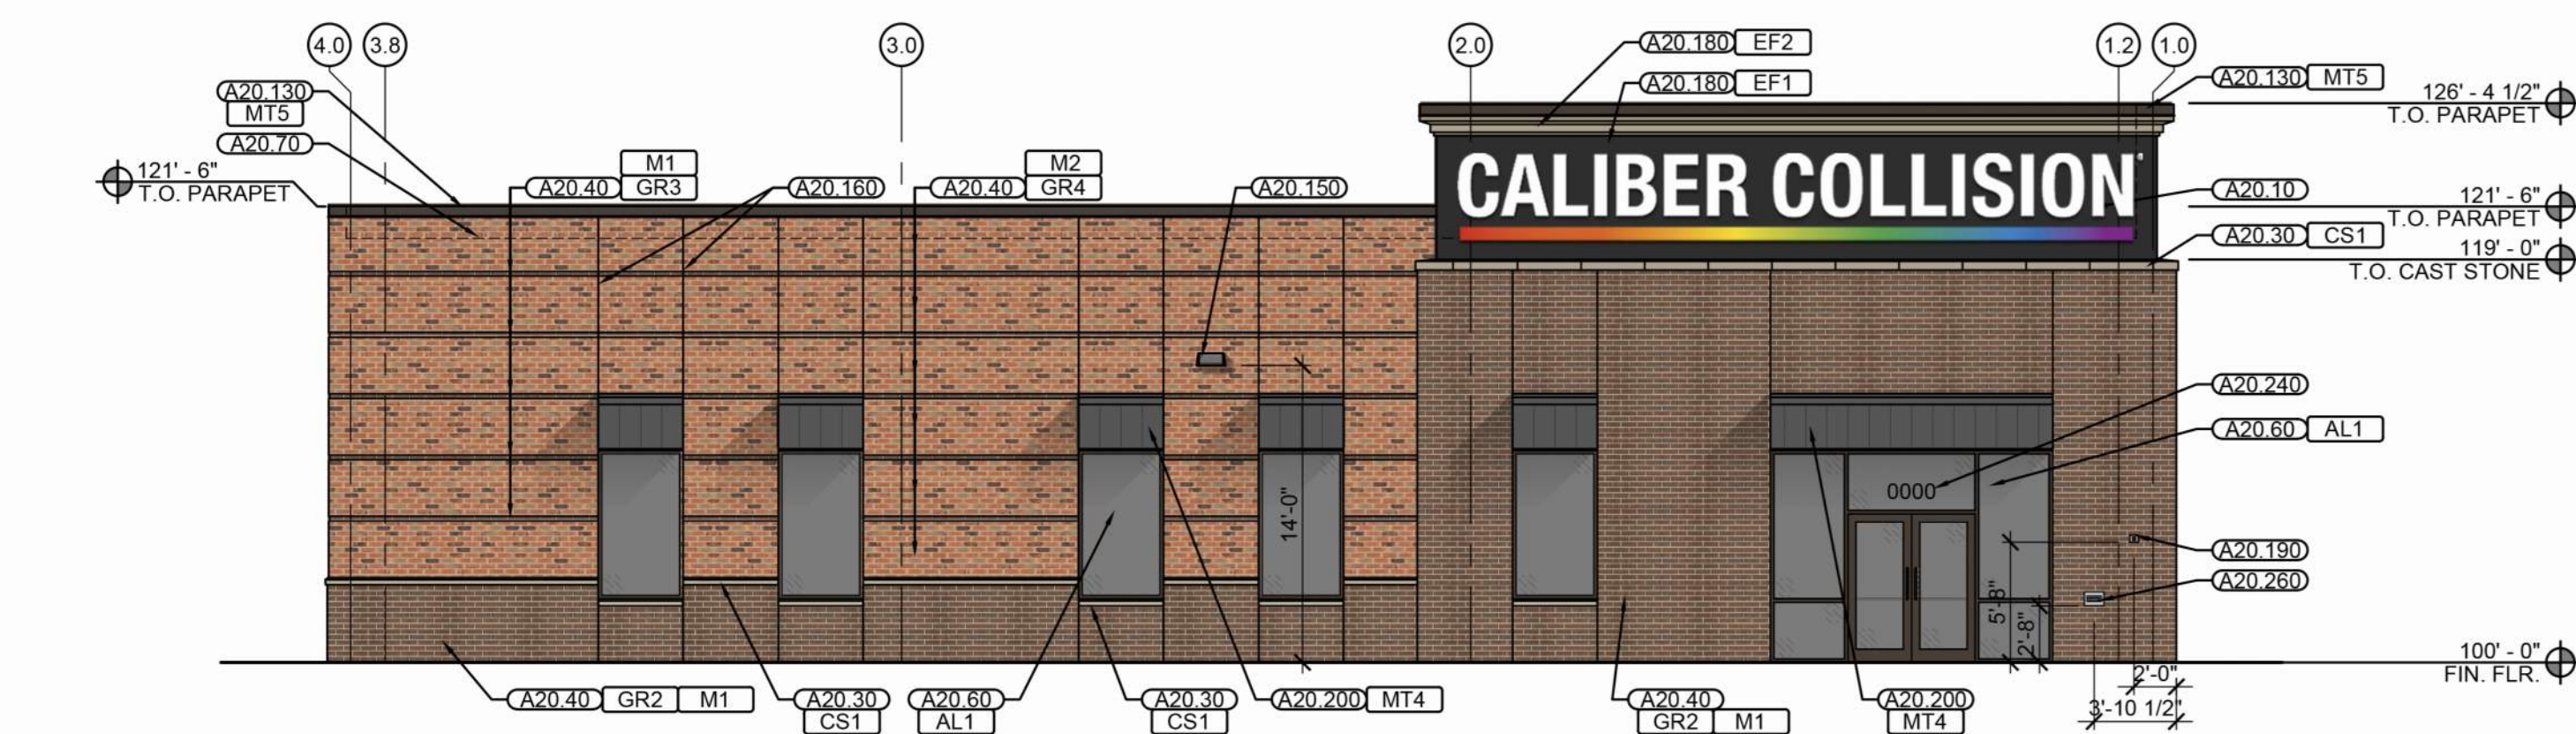

01 FRONT ELEVATION  
SCALE: 1/8" = 1'-0"

PLAN EAST

MATERIAL CALCULATIONS			PERCENT
RIGHT	BRICK	1,209 S.F.	65.1%
	EIFS	500 S.F.	26.9%
	R-PANEL	149 S.F.	8.0%
	TOTAL	1,858 S.F.	100%
REAR	BRICK	400 S.F.	30.0%
	R-PANEL	937 S.F.	70.0%
	TOTAL	1,337 S.F.	100%
LEFT	BRICK	1,044 S.F.	72.1%
	EIFS	254 S.F.	17.6%
	R-PANEL	149 S.F.	10.3%
	TOTAL	1,447 S.F.	100%
FRONT	BRICK	1,489 S.F.	86.5%
	EIFS	232 S.F.	13.5%
	TOTAL	1,721 S.F.	100%
ALL FACADES			
	BRICK	4,142 S.F.	65.1%
	EIFS	986 S.F.	15.5%
	R-PANEL	1,235 S.F.	19.4%
	TOTAL	6,363 S.F.	100%

- KEY NOTES:
- A20.10 SIGNAGE (BY OTHERS) WITH PLYWOOD BACKING (BY GC); GC TO PROVIDE CIRCUIT IN CONDUIT FROM SIGN TO LIGHT CONTROL PANEL
  - A20.20 BLACK FENCE AND GATE, HEIGHT NOTED BESIDE KEYNOTE; PAINT ALL FENCE PARTS BLACK (POLES, ATTACHMENTS, ETC.); REF. SP1.0 & SP1.1 FOR FENCE TYPE
  - A20.30 CAST STONE SILL/ WATER TABLE
  - A20.40 MODULAR BRICK VENEER
  - A20.50 METAL GUTTER (PROVIDED BY METAL BUILDING AND GC INSTALLED)
  - A20.60 STOREFRONT / GLAZING
  - A20.70 ROOF LINE BEYOND
  - A20.80 PRE-FINISHED 6" W X 4" D (SQUARE) METAL DOWNSPOUT, FURNISHED BY METAL BUILDING AND GC INSTALLED
  - A20.90 FACTORY FINISHED OVERHEAD DOOR, SADDLE TAN
  - A20.100 HOLLOW METAL DOOR AND FRAME
  - A20.110 PRE-FINISHED METAL BUILDING SIDING
  - A20.120 EXHAUST AND AIR INTAKE (REF. GARMAT SHEETS)
  - A20.130 PRE-FINISHED METAL COPING, PROVIDED BY METAL BUILDING AND GC INSTALLED [MT5]
  - A20.140 PRE-FINISHED METAL BUILDING "R" PANEL ROOFING
  - A20.150 WALL MOUNTED LIGHT FIXTURE (REF. MEP)
  - A20.160 CONTROL JOINT
  - A20.170 METAL EQUIPMENT SCREENING, OUTWARD FACE OF ALL SCREENING TO BE R-PANEL, ALL SUPPORT FRAMING TO BE PRIMED AND PAINTED CHARCOAL GREY
  - A20.180 EIFS VENEER
  - A20.190 KNOX BOX
  - A20.200 PRE-FINISHED METAL AWNING [MT4]
  - A20.210 PRE-FINISHED METAL STANDING SEAM ROOFING
  - A20.220 CONCRETE FILLED STEEL BOLLARD WITH YELLOW PLASTIC SLEEVE, REF. 05/SP1.2
  - A20.230 LOUVER, PROVIDE FRAMED OPENINGS, VERIFY SIZE WITH MEP
  - A20.240 STREET ADDRESS NUMBERS TO BE SIZED AND COLORS TO BE APPROVED BY FIRE MARSHAL
  - A20.250 SURFACE MOUNTED EXTERIOR RATED FIRE EXTINGUISHER CABINET, CONFIRM LOCATION WITH FIRE MARSHAL FOR ADJUSTMENT
  - A20.260 THROUGH WALL KEY DROP

#### MATERIAL LEGEND



FINISH SCHEDULE X11				VERSION 24.07.11
FINISH KEY	DESCRIPTION/ LOCATION	COLOR	IDENTIFICATION/ FINISH/ STYLE	
AL1	STOREFRONT SYSTEM	DARK ANODIZED BRONZE	ALUMINUM FRAME	
CS1	CAST STONE (REF. ELEVATIONS)	BUFF	SMOOTH	
EF1	EXTERIOR EIFS (TOWER ELEMENT)	TRICORN BLACK (SW 6258)	SAND PEBBLE	
EF2	EXTERIOR EIFS (CORNICHE)	CUSTOM MATCH CAST STONE COLOR	SAND PEBBLE	
EF3	EXTERIOR EIFS (FIELD)	NOMADIC DESERT (SW 6107)	SAND PEBBLE	
GR2	EXTERIOR MASONRY MORTAR FOR STONE	10X BUFF	TYPE S	
GR3	EXTERIOR MASONRY MORTAR FOR BRICK	30X LT. BROWN	TYPE S	
GR4	EXTERIOR MASONRY MORTAR FOR BRICK	97X SUPER BLACK	TYPE S	
M1	EXTERIOR MASONRY - WAINSCOT, TOWER, ACCENT	STRATFORD		
M2	EXTERIOR MASONRY - FIELD	MILWAUKEE		
MT1	PREFINISHED METAL SIDING EXT. WALL R-PANELS	SADDLE TAN	SPECTRALITE 2000	
MT2	PREFINISHED METAL ROOFING ROOF PANELS AND REAR CANOPY	SOLAR WHITE	SPECTRALITE 2000	
MT3	PREFINISHED METAL ROOFING AT PORTE COCHERE	MEDIUM BRONZE	SPECTRALITE 2000	
MT4	PREFINISHED STANDING SEAM AT AWNINGS	CHARCOAL (MCELROY METAL)		
MT5	PREFINISHED SHOP TRIM, GUTTER, DOWNSPOUTS	BURNISHED SLATE	SPECTRALITE 2000	
MT6	PREFINISHED TRIM, GUTTER, DOWNSPOUT @ PORTE COCHERE	COAL BLACK	SPECTRALITE 2000	
PT3	EXTERIOR DOOR PAINT; INTERIOR SHOP DOOR PAINT	NOMADIC DESERT	SW 6107 - EXTERIOR LOW SHEEN - UDB	
PT5	EXTERIOR EXPOSED STEEL	URBANE BRONZE	SW 7048 - EXTERIOR LOW SHEEN - UDB	
PT6	EXTERIOR FINISH	SURREY BEIGE	SW 9116 - EXTERIOR LOW SHEEN - UDB	



ARCHITECT  
BRET FLORY  
1913 GARDENGROVE COURT  
PLANO, TEXAS 75075  
PH: 972.467.9749  
bflory@crossarchitects.com


## CALIBER COLLISION

### BUILDING ELEVATIONS


FAIRLAWN DRIVE  
WINSTON SALEM, NC

DRAWN	DATE	PROJECT NO.	CITY PROJECT NO.	SHEET NO.
-	24.12.20	-	-	-




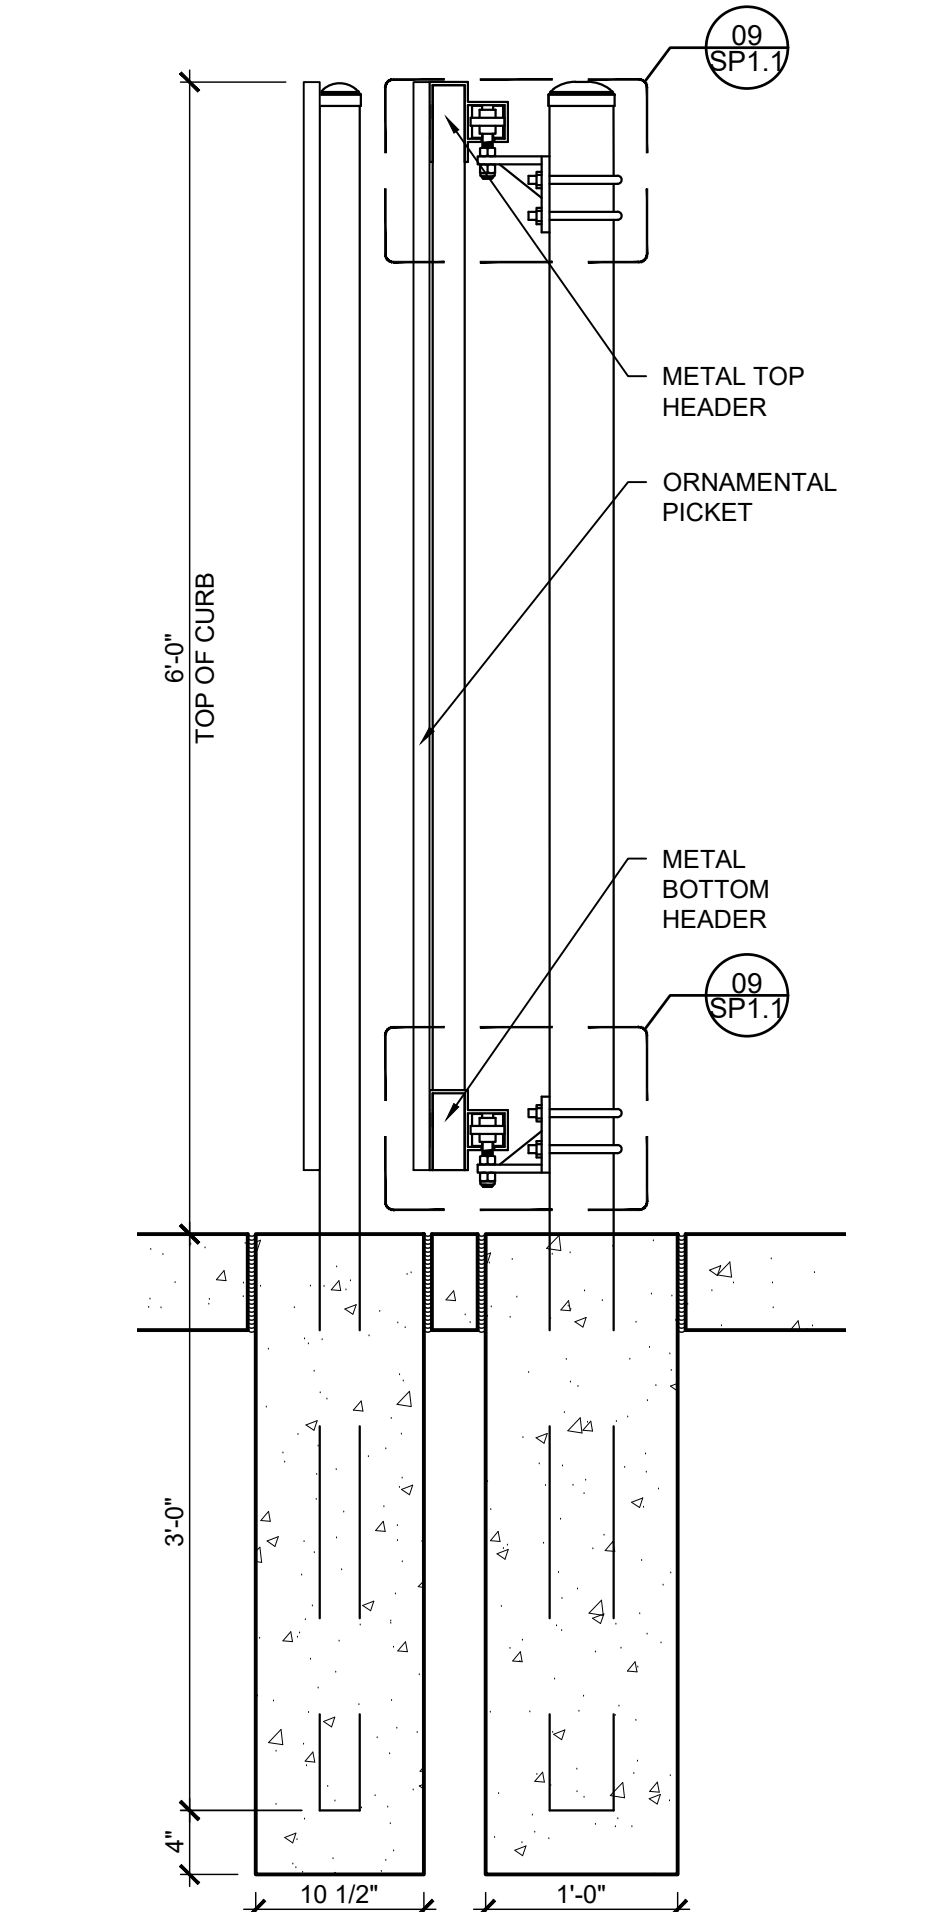


06 ORNAMENTAL GATE SECT.  
SCALE: 1" = 1'-0"

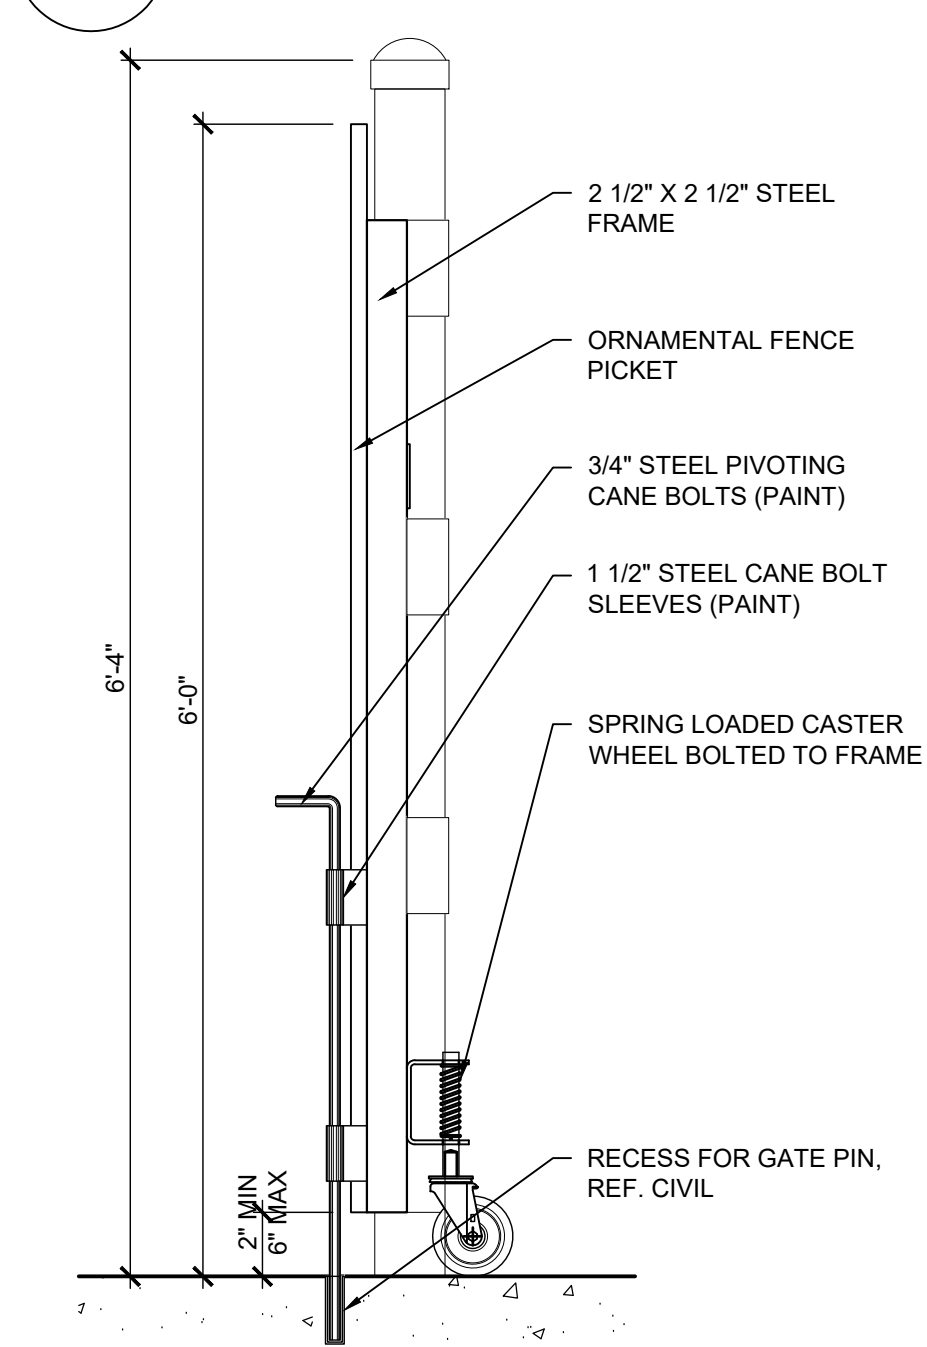


03 ORNAMENTAL GATE SECT.  
SCALE: 1" = 1'-0"

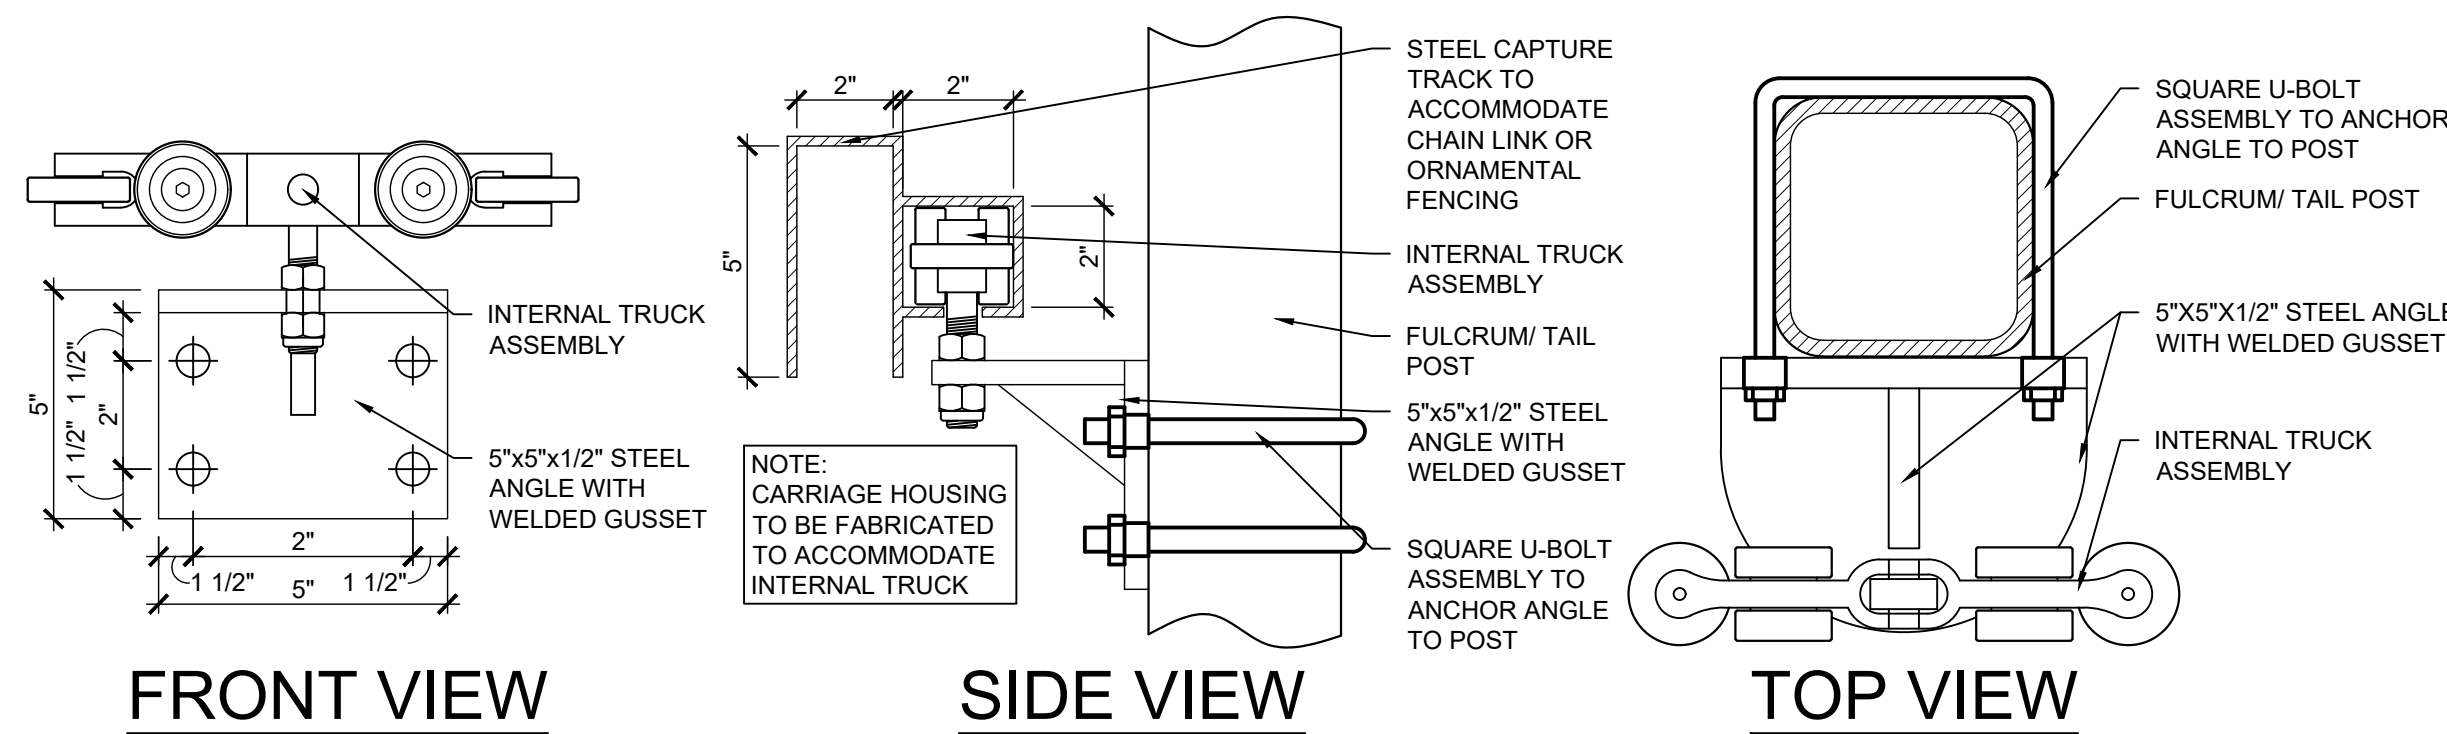


09 ORNAMENTAL CANTILEVER GATE DETAILS  
SCALE: 1/2" = 1'-0"

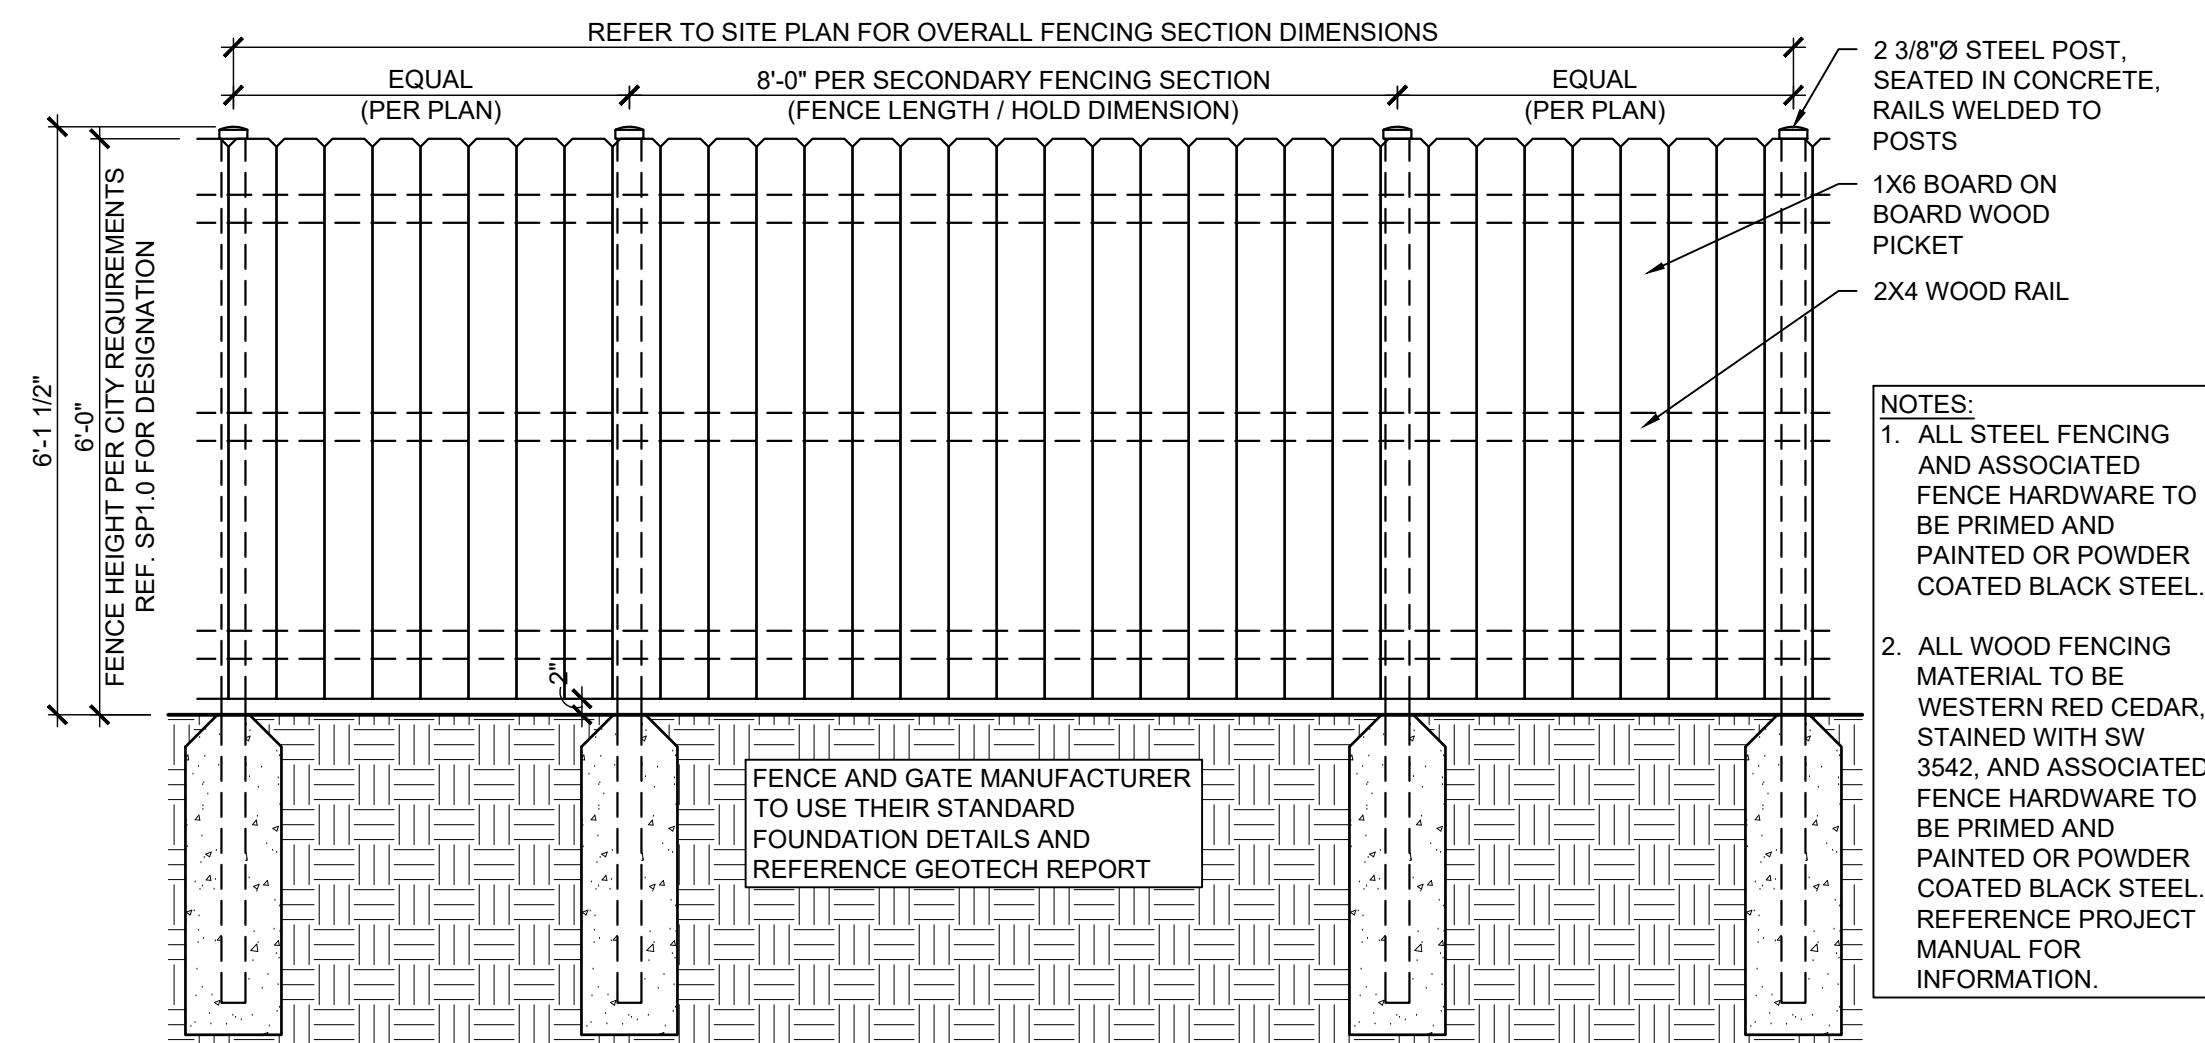


08 CHAIN LINK FENCE ELEVATION  
SCALE: 1/2" = 1'-0"

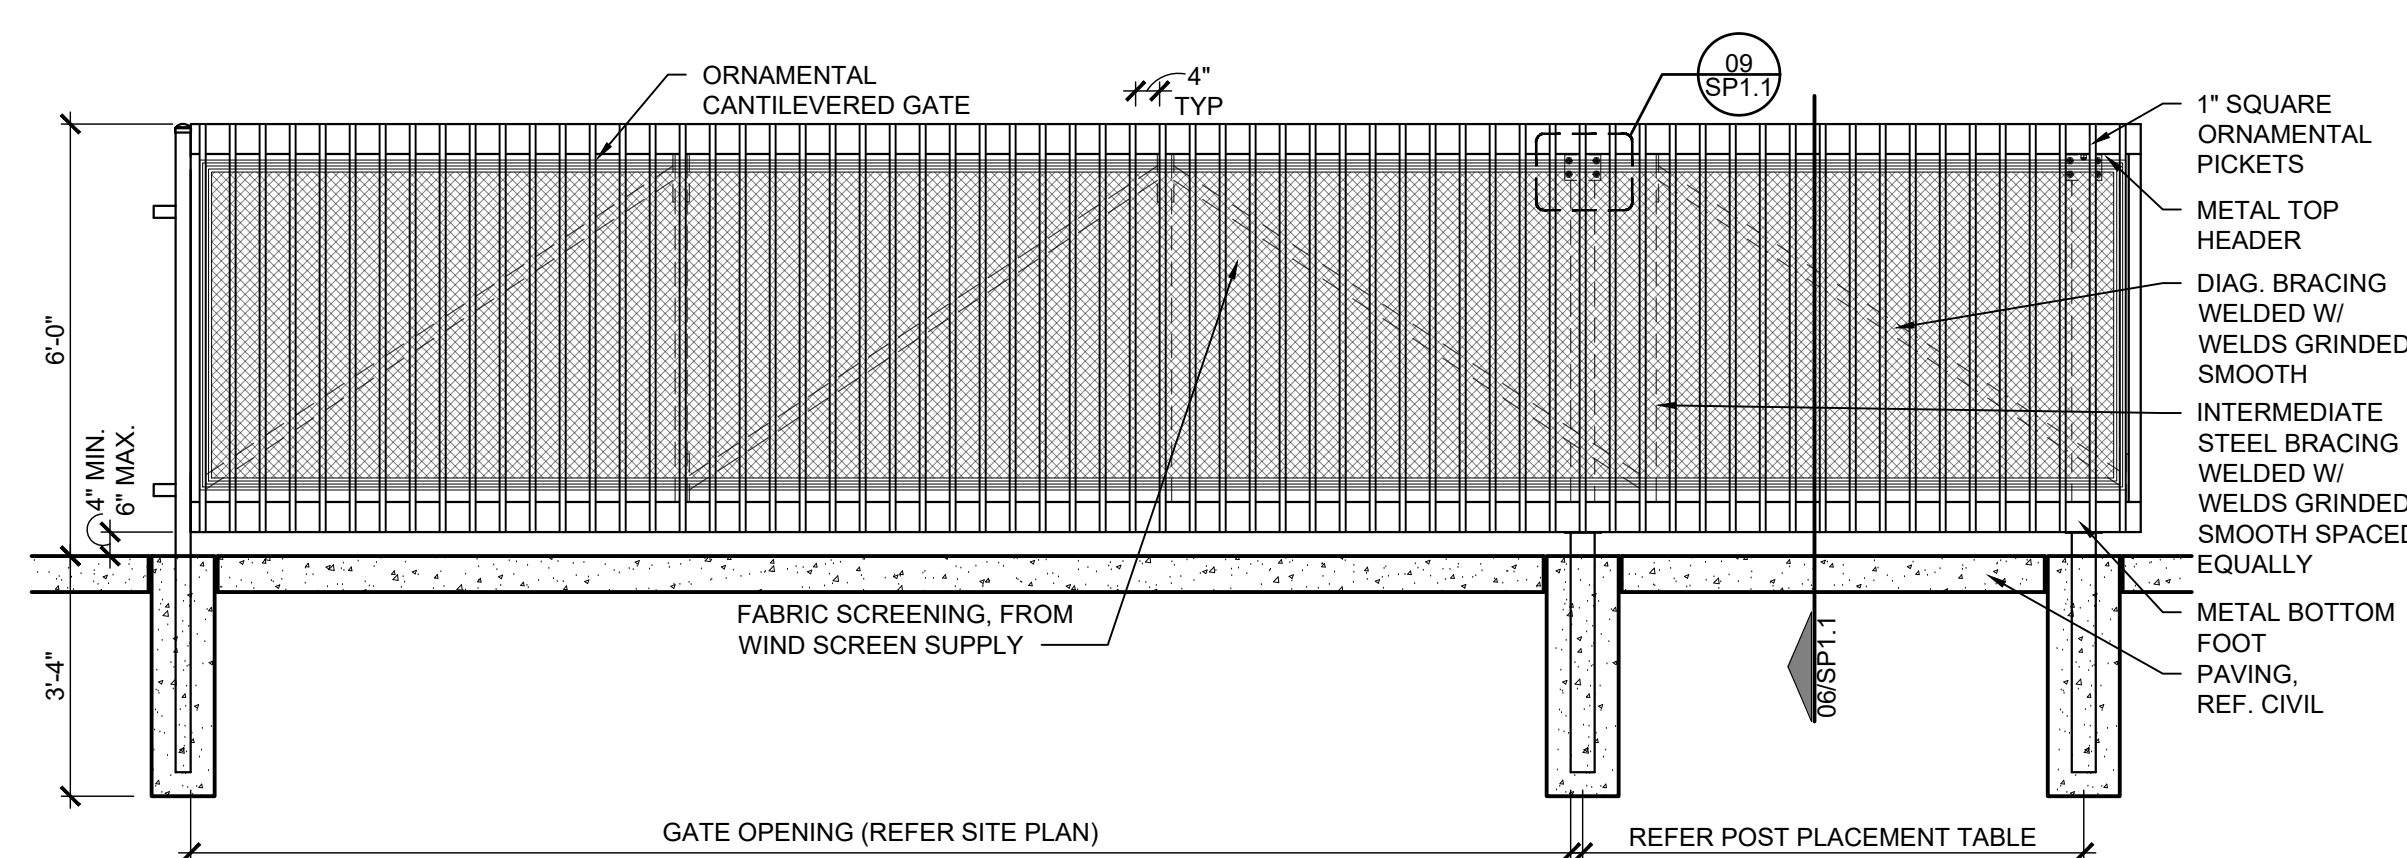


05 ORNAMENTAL CANTILEVER GATE ELEVATION  
SCALE: 3/8" = 1'-0"

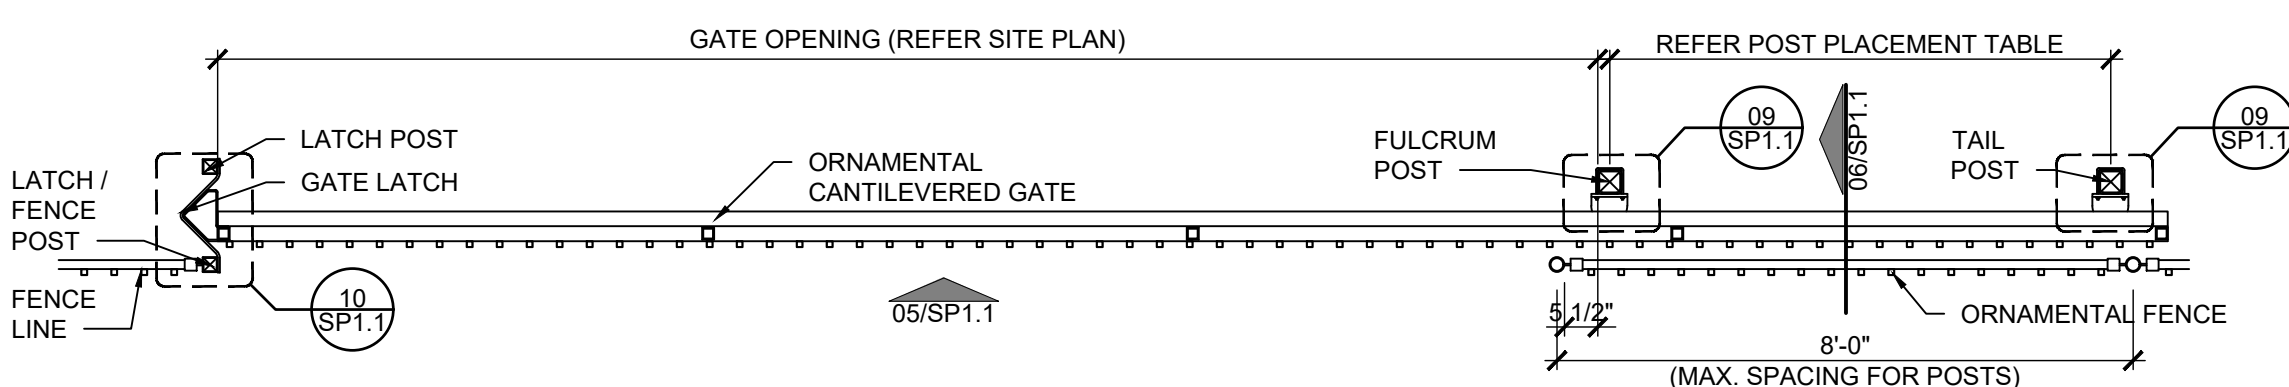


02 ORNAMENTAL CANTILEVER GATE PLAN  
SCALE: 3/8" = 1'-0"

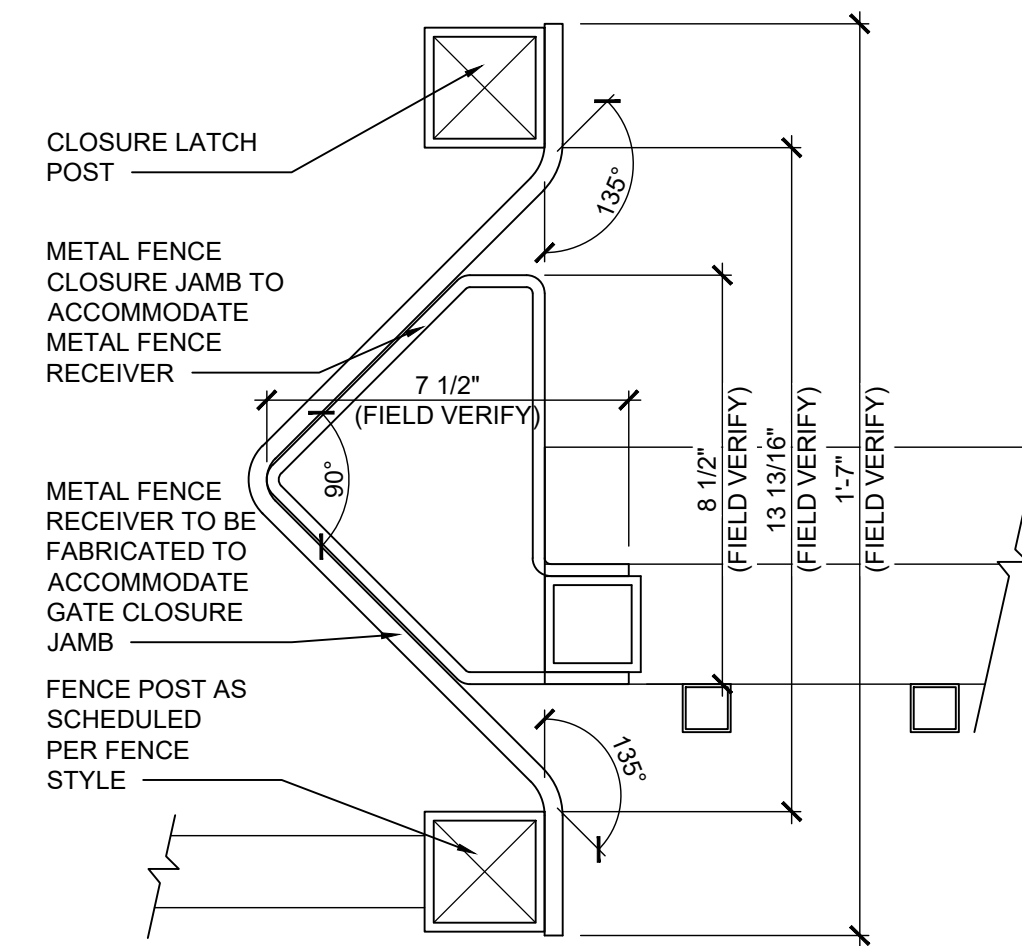


10 ORNAMENTAL CANTILEVER GATE DETAIL  
SCALE: 1/2" = 1'-0"

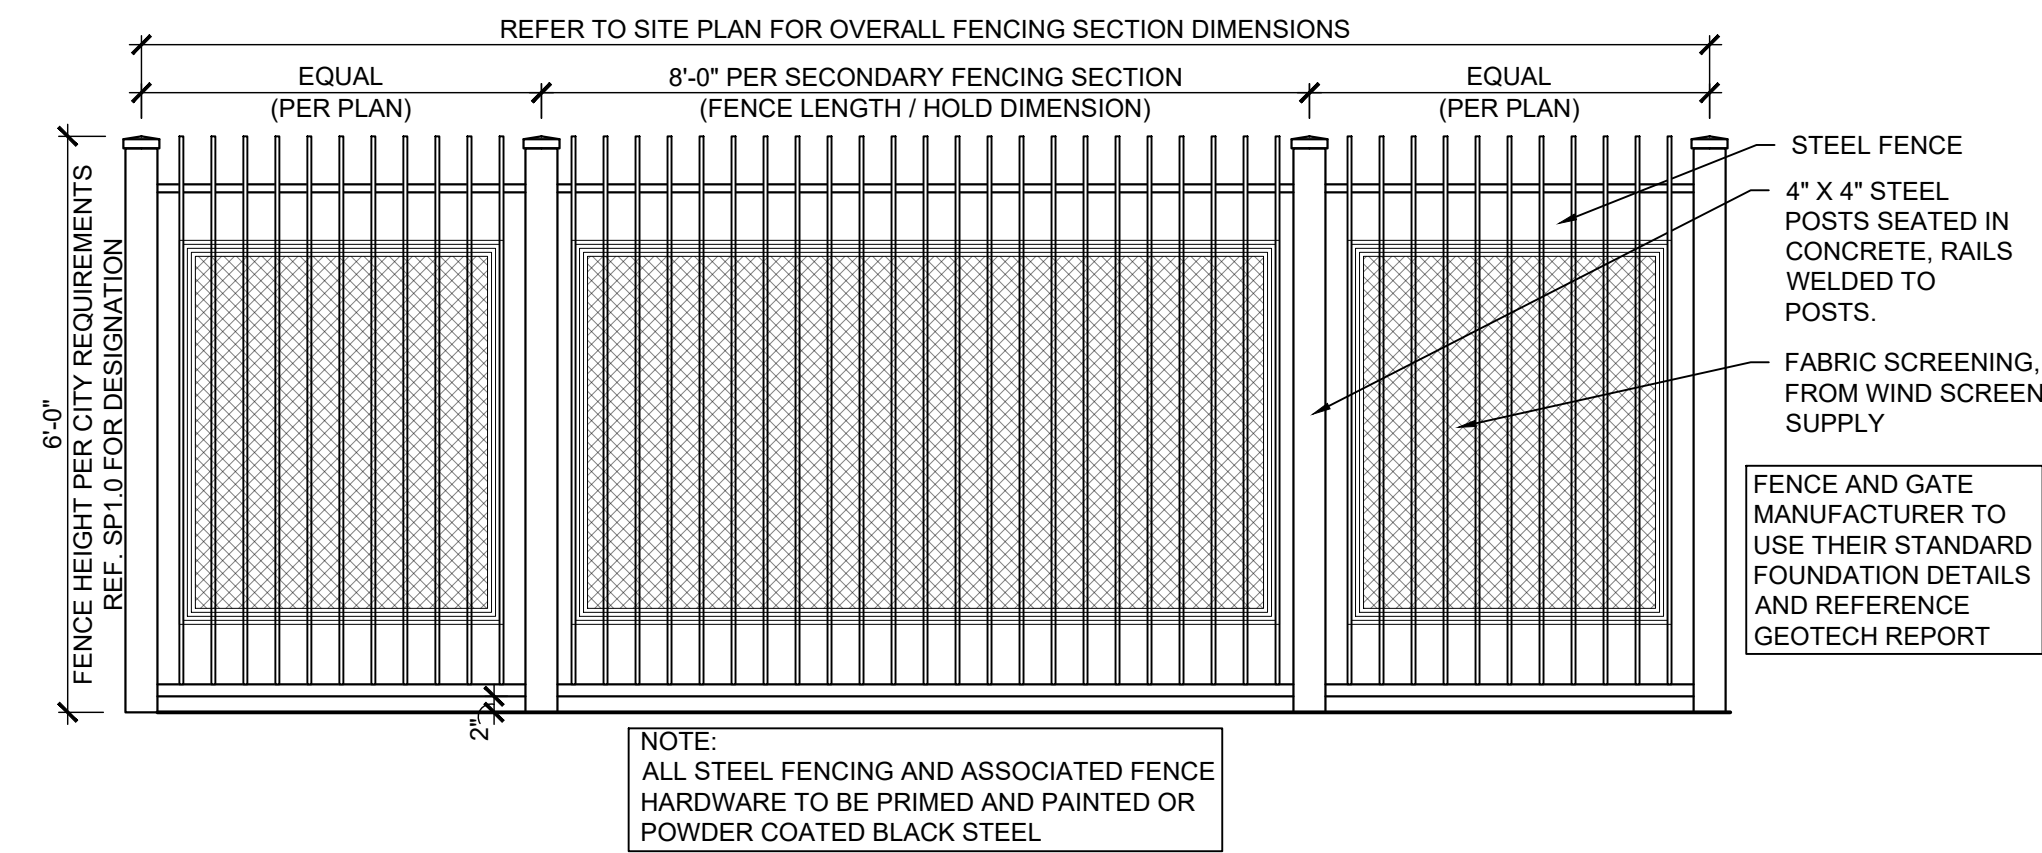

07 ORNAMENTAL FENCE ELEVATION  
SCALE: 1/2" = 1'-0"

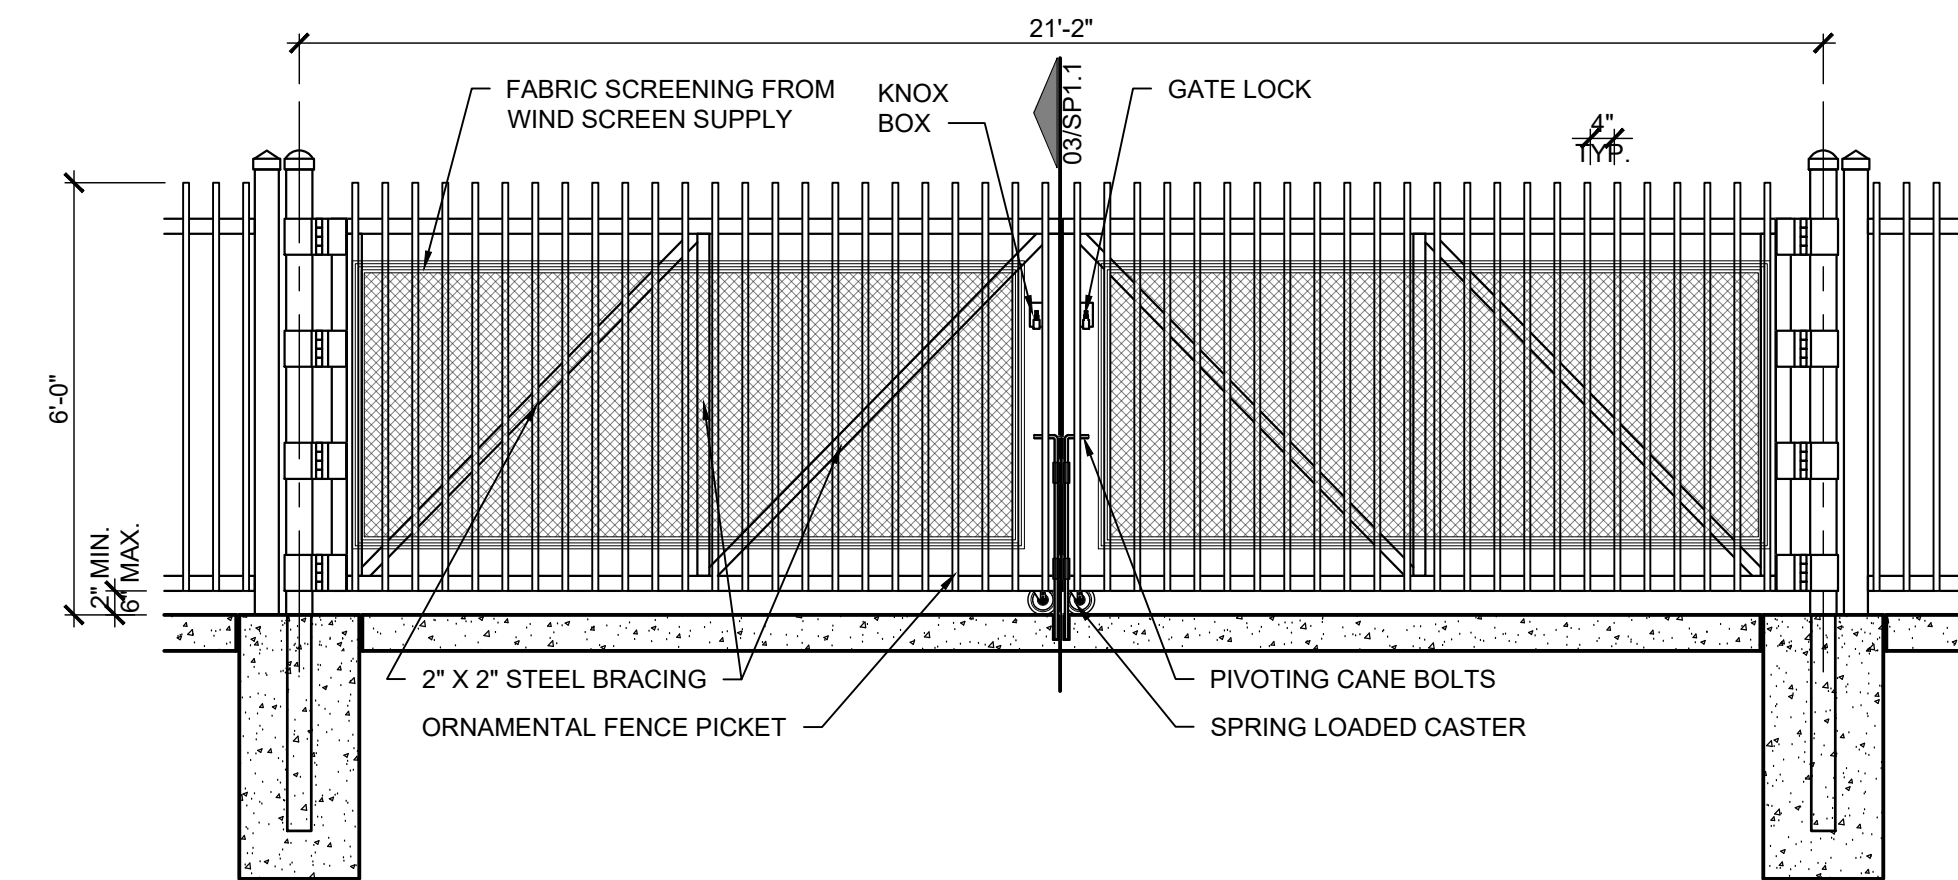

04 ORNAMENTAL SWING GATE ELEVATION  
SCALE: 3/8" = 1'-0"

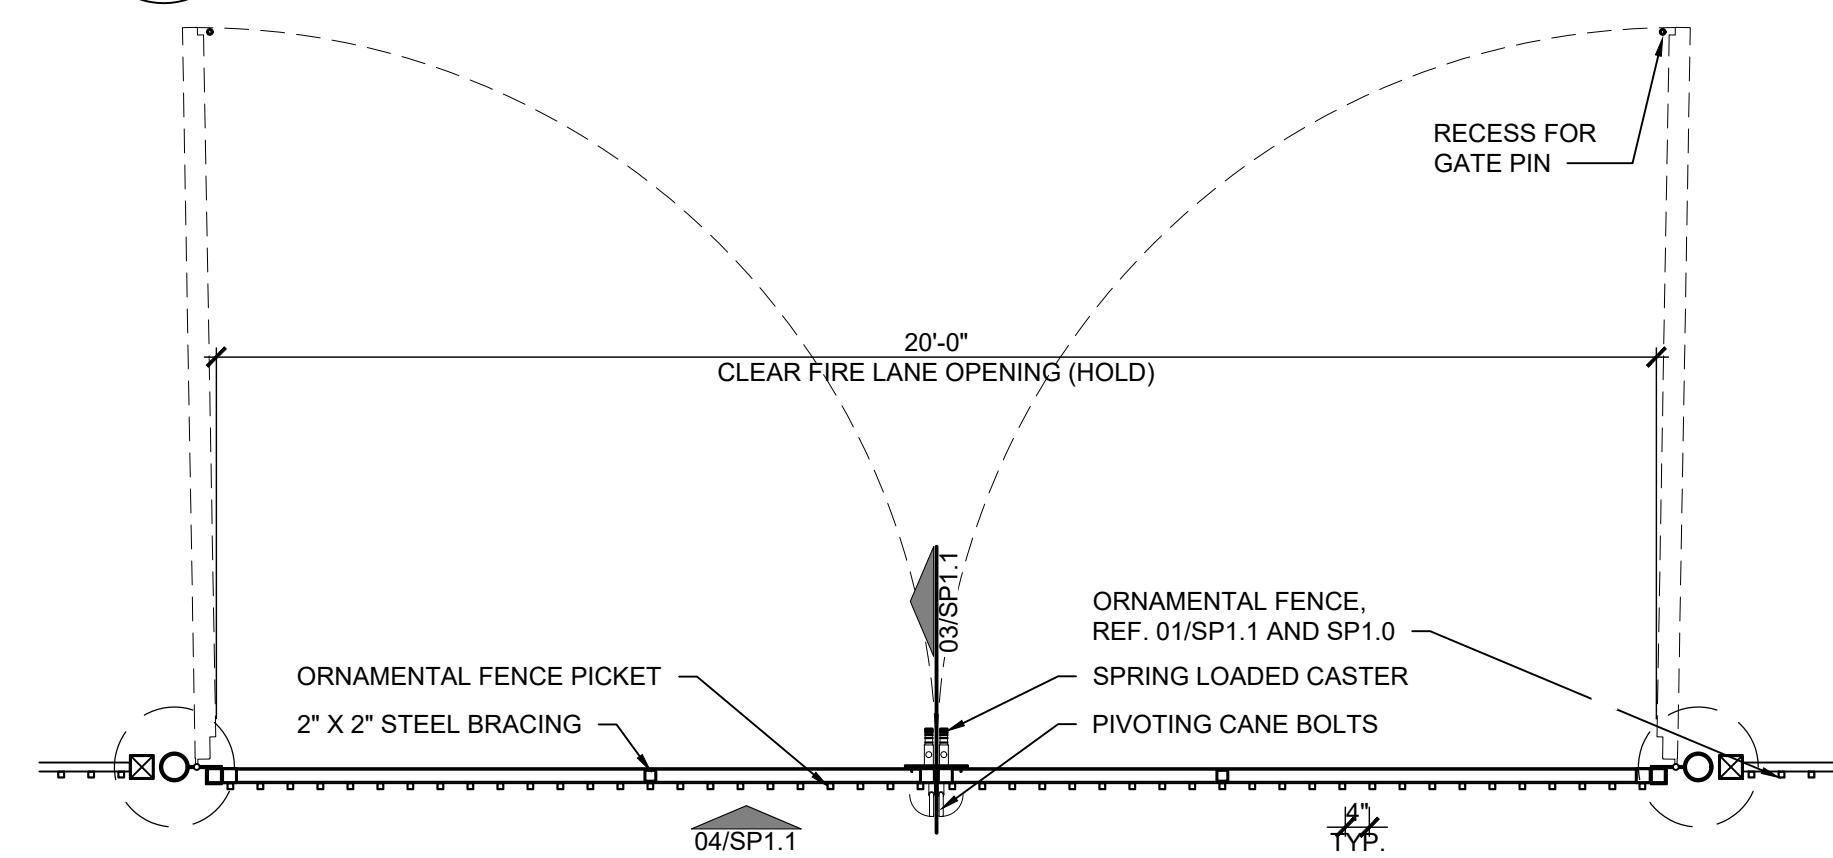

01 ORNAMENTAL SWING GATE PLAN  
SCALE: 3/8" = 1'-0"





CALIBER COLLISION





CALIBER COLLISION

CALIBER COLLISION