

SPECIAL USE PERMIT & REZONING NOTES

1. THE PROJECT MAY BE CONSTRUCTED IN PHASES.

2. ARCHITECTURAL BUILDING FOOT PRINTS MAY CHANGE PER FINAL DESIGN & PERMIT PLANS. BUILDING FOOT PRINT MODIFICATIONS & SITE LAYOUT MODIFICATIONS SHALL REQUIRE REVIEW BY PLANNING STAFF.

3. GUTTERS & DOWNSPOUTS ARE SHOWN SUBJECT TO FINAL STORMWATER MANAGMENT, & STORM DRAINAGE DESIGN.

4. ARCHITECTURAL ELEVATIONS ARE SCHEMATIC WITH THE INTENT TO ESTABLISH A PALLET OF COLORS & MATERIALS THAT ARE COMPATIBLE WITH EXISTING BUILDINGS & ADJACENT RESIDENTIAL NEIGHBORHOODS.

5. SCHEMATIC ELEVATIONS MAY NOT SHOW THE FULL EXTENT OF MECHANICAL LOUVERS, ROOF VENTS, ROOF OR WALL PENETRATIONS UNTIL THE DESIGN IS FINALIZED.

6. BUILDING HEIGHTS SHOWN MAY VARY AS THE SITE DESIGN 8 FINAL GRADING PLAN IS ESTABLISHED.

AWOV.

PLANNING ARCHITE ON STREET, SUITE G TH CAROLINA 27701



ALEM, 501 WASHII

TROSA TRIAD

# SHEET NOTES - ELEVATIONS

E001 EMERGENCY LIGHT

E002 WALLPACK LIGHT FIXTURE

E003 PRE-FINISHED METAL GUTTER & DOWNSPOUT

E004 NOT USED

E005 CHAIN LINK FENCE GATES

E006 PRE-FIN. MECHANICAL EXHAUST LOUVER

E007 PRE-FINISHED METAL RAKE TRIM & FASCIA

E008 PIPE AND TUBE RAILING & GUARDS

E009 PLASTIC UNIT SKYLIGHT

E010 CONTINUOUS RIDGE VENT

E011 FIBER CEMENT BOARD TRIM CARPENTRY

SHEET NOTES - ELEVATIONS

FINISH LEGEND - EXTERIOR MATERIALS

M 07 DE SIZ

MR01
07 6113 STANDING SEAM METAL ROOFING
DESCRIPTION: SHEET METAL ROOFING
SIZE: REFER TO ELEVATIONS

CV 033 DES Ret SIZE

CW01
033000 CAST IN PLACE CONCRETE
DESCRIPTION: Cast In Place Concrete
Retaining Walls & Foundations
SIZE: Refer to Sections and Elevations

SD01 07 4646 FIBER CEMENT SIDING DESCRIPTION: HORIZONTAL SIDING SIZE: REFER TO ELEVATIONS SHEET NAME:
BASKETBALL PAVILION
ELEVATIONS

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ARE INSTRUMENTS OF SERVICE AND AS SUCH SHALL REMAIN THE
PROPERTY OF THE ARCHITECT. THEY HAVE BEEN PREPARED FOR
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PHASE:
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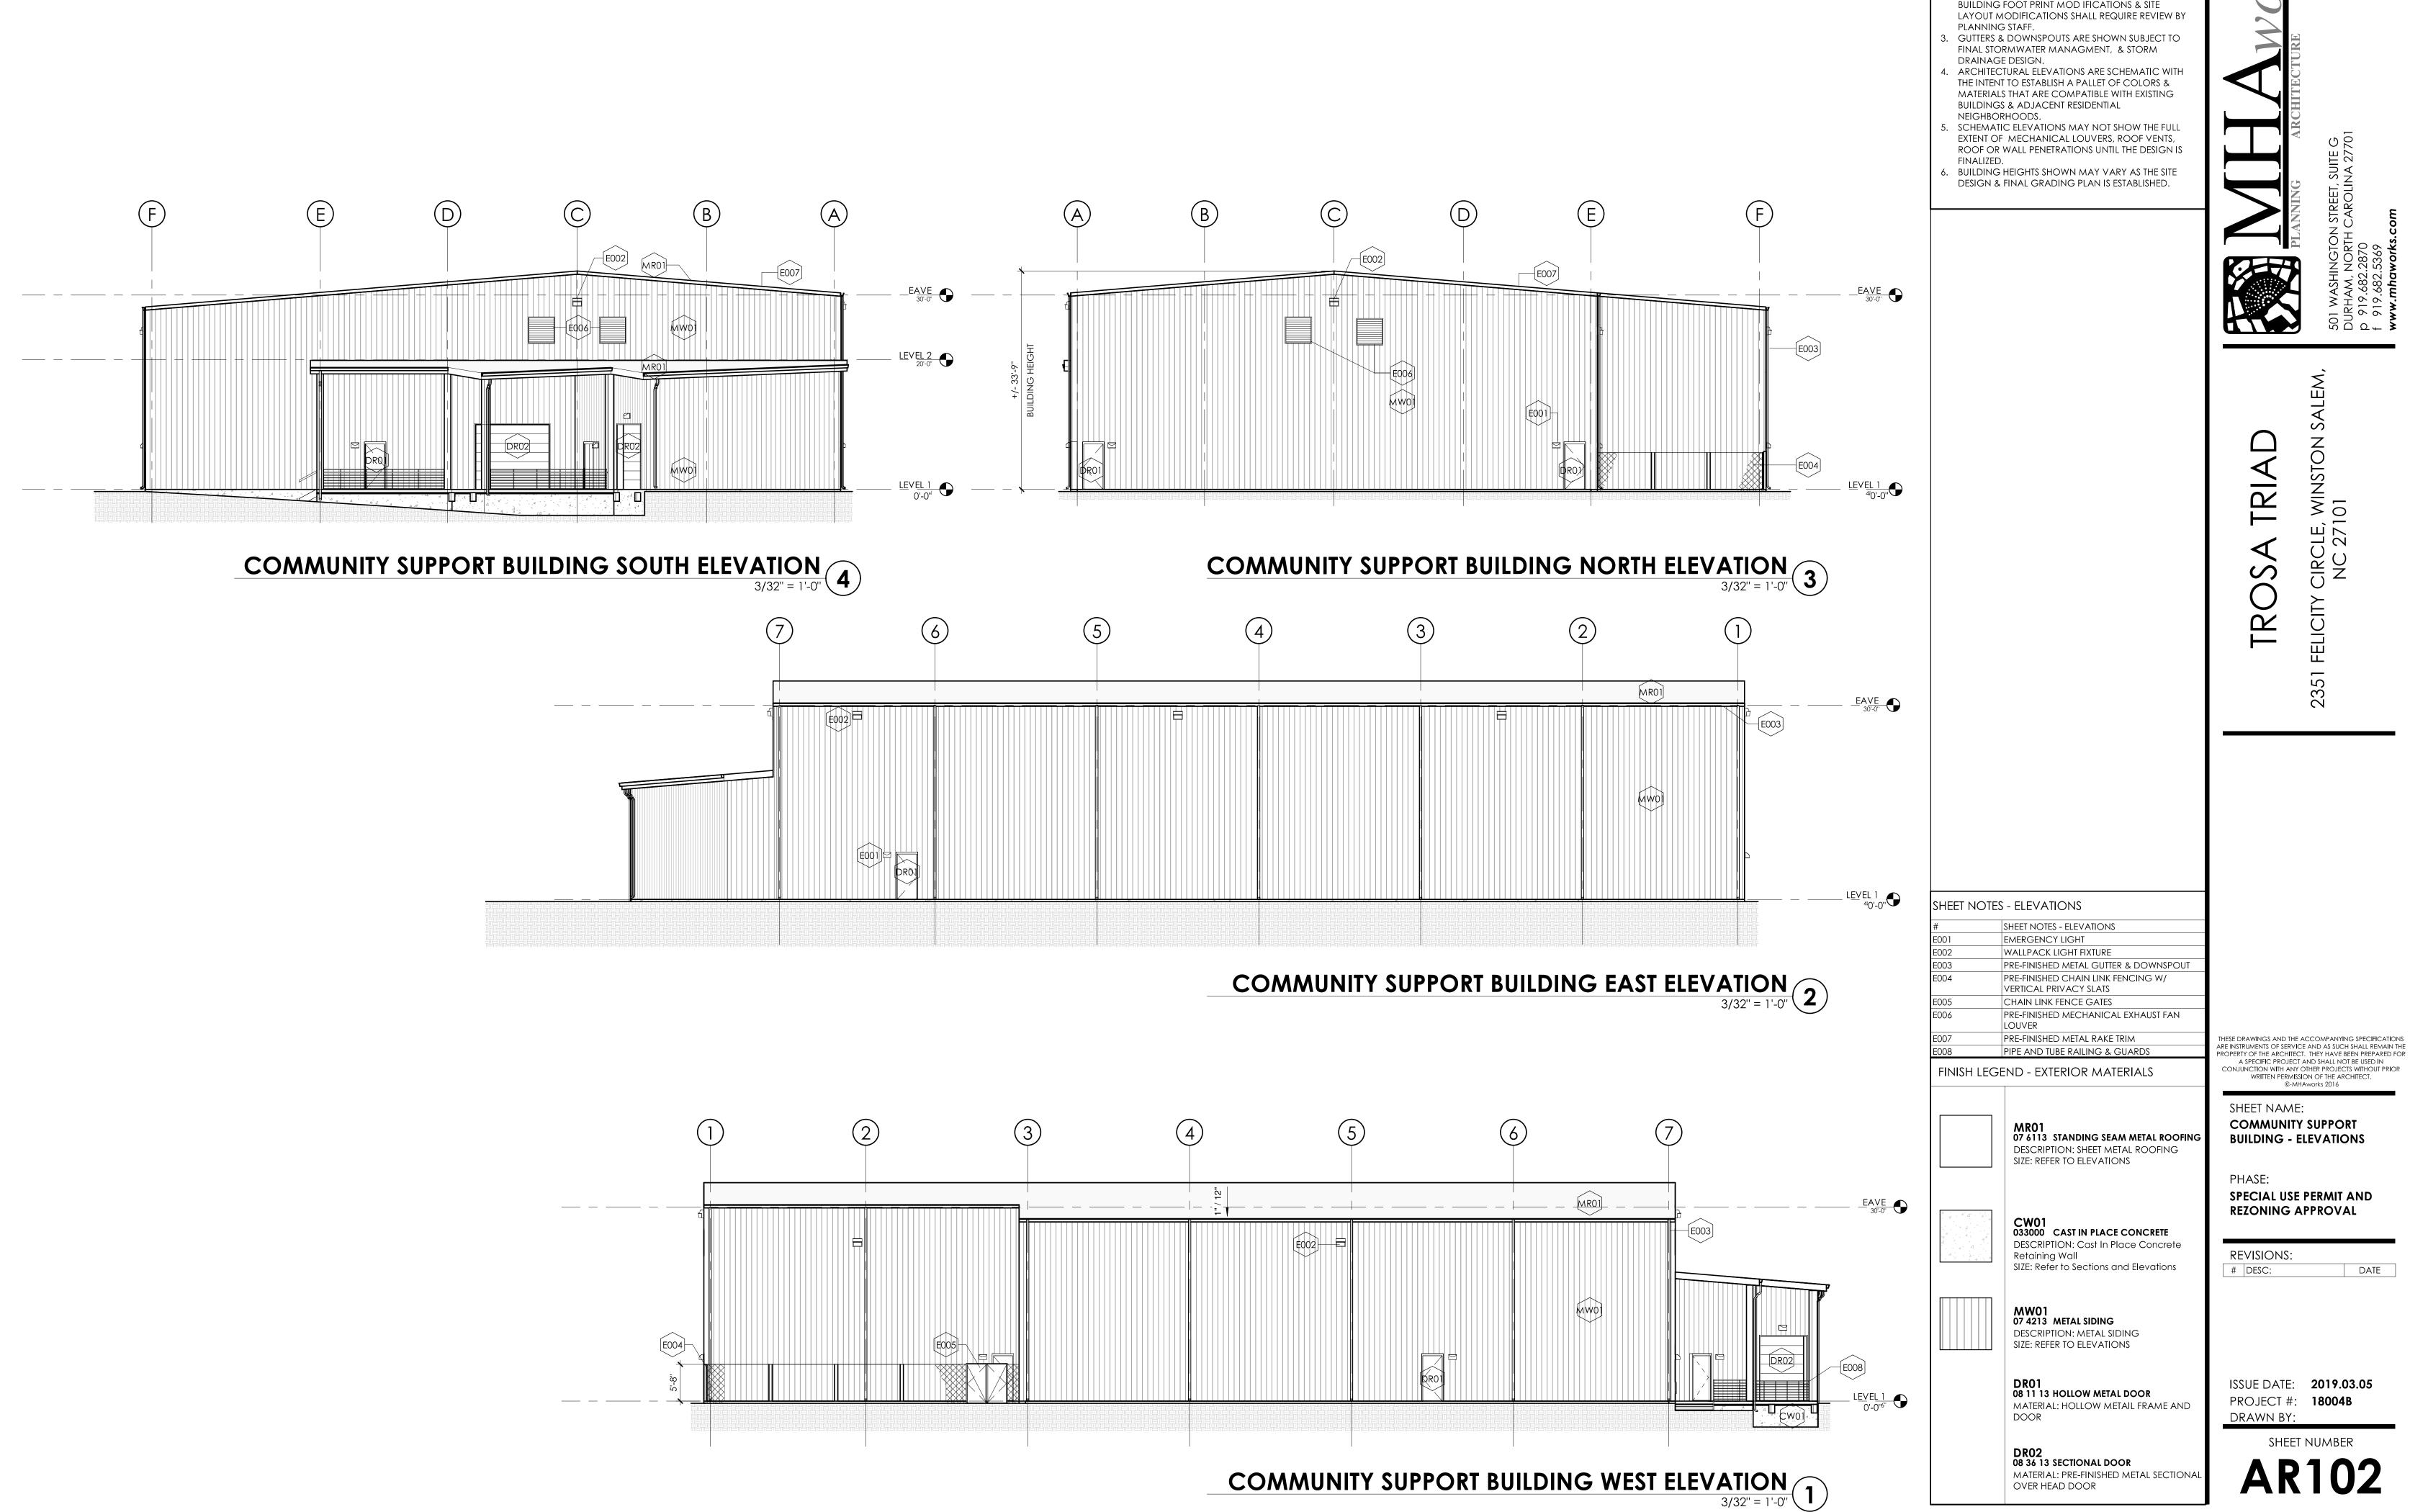
REVISIONS:
# | DESC:

SC: DATE

ISSUE DATE: **2019.03.05**PROJECT #: **18004B**DRAWN BY:


SHEET NUMBER

**AR101** 



SPECIAL USE PERMIT AND REZONING

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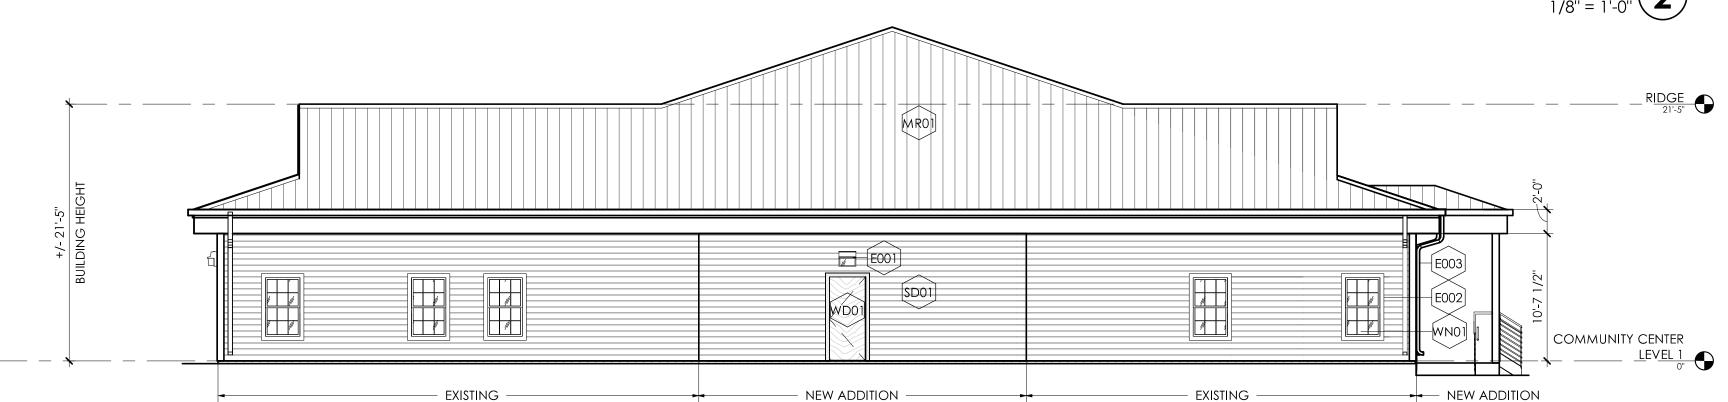
## COMMUNITY CENTER - WEST ELEVATION 1/8" = 1'-0" 4

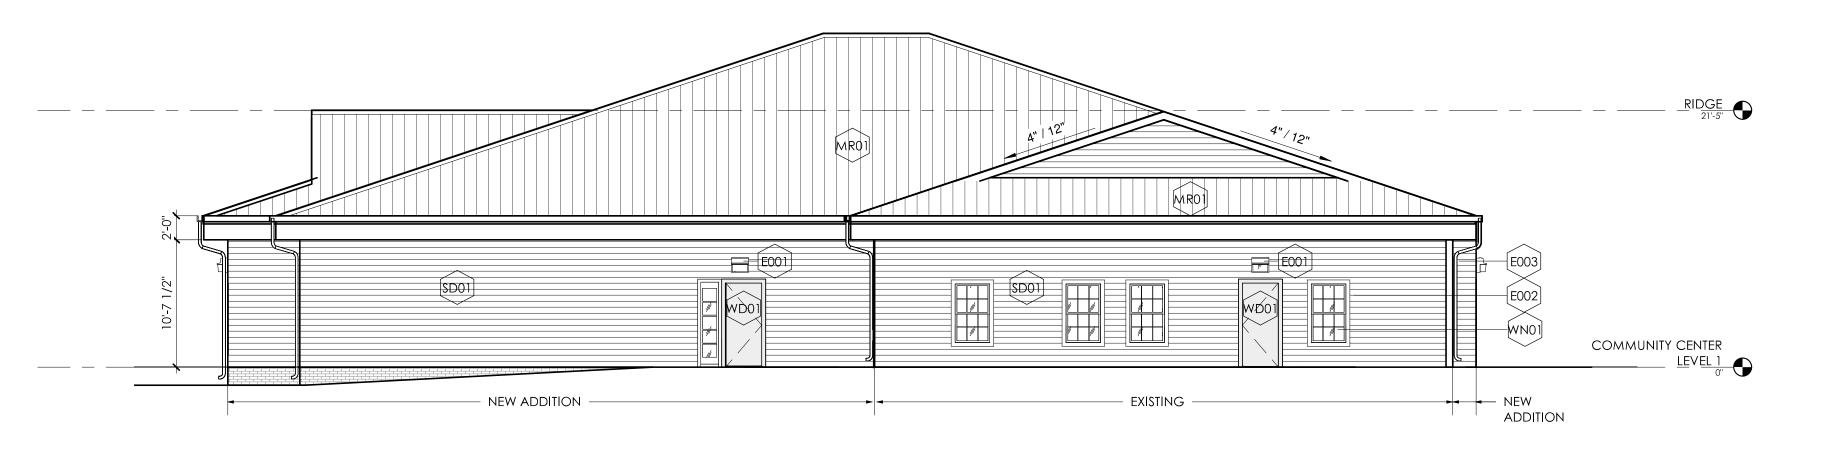

## COMMUNITY CENTER - NORTH ELEVATION 1/8" = 1'-0" 3



## COMMUNITY CENTER - EAST ELEVATION 1/8" = 1'-0" 2



COMMUNITY CENTER - SOUTH ELEVATION
1/8" = 1'-0"
1

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SHEET NOTES - ELEVATIONS E001 EMERGENCY LIGHT


SHEET NOTES - ELEVATIONS

E002 FIBER CEMENT TRIM FIN.CARPENTRY E003 PRE-FINISHED METAL GUTTER & DOWNSPOUT

FINISH LEGEND - EXTERIOR MATERIALS

MR01 07 6113 STANDING SEAM METAL ROOFING DESCRIPTION: SHEET METAL ROOFING SIZE: REFER TO SECTIONS AND ELEVATIONS

07 4646 FIBER-CEMENT SIDING MATERIAL: FIBER-CEMENT SIDING COLOR: COLOR 1

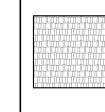

STYLE: HORIZONTAL SIDING PANEL NOTE: PRIMARY FIELD SIDING 07 4646 FIBER-CEMENT SIDING MATERIAL: FIBER-CEMENT SIDING

COLOR: COLOR 2 STYLE: SHINGLES NOTE: PRIMARY FIELD SIDING



04 2000 UNIT MASONRY MATERIAL: CLAY BRICK MASONRY SIZE: MODULAR UNIT NOTE: PRIMARY FIELD BRICK



08 5413 FIBERGLASS CLAD WD. WINDOW NAME: ANDERSEN A-SERIES DESCRIPTION: FIBERGLASS AND WOOD

MANUFACTURER: ANDERSEN WD01 06 20 13 WOOD, EXT. FINISH CARPENTRY

DOOR

NAME: PAINTED WOOD DESCRIPTION: POST AND RAIL

SF01 07 42 93 HARDIE SOFFIT MATERIAL: HARDIE PERFORATED SOFFIT

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> SHEET NAME: COMMUNITY BUILDING **EXPANSION - ELEVATIONS**

PHASE: SPECIAL USE PERMIT AND

REZONING APPROVAL

DATE

**REVISIONS:** 

# DESC:

DR01 08 11 13 HOLLOW METAL DOOR MATERIAL: HOLLOW METAIL FRAME AND

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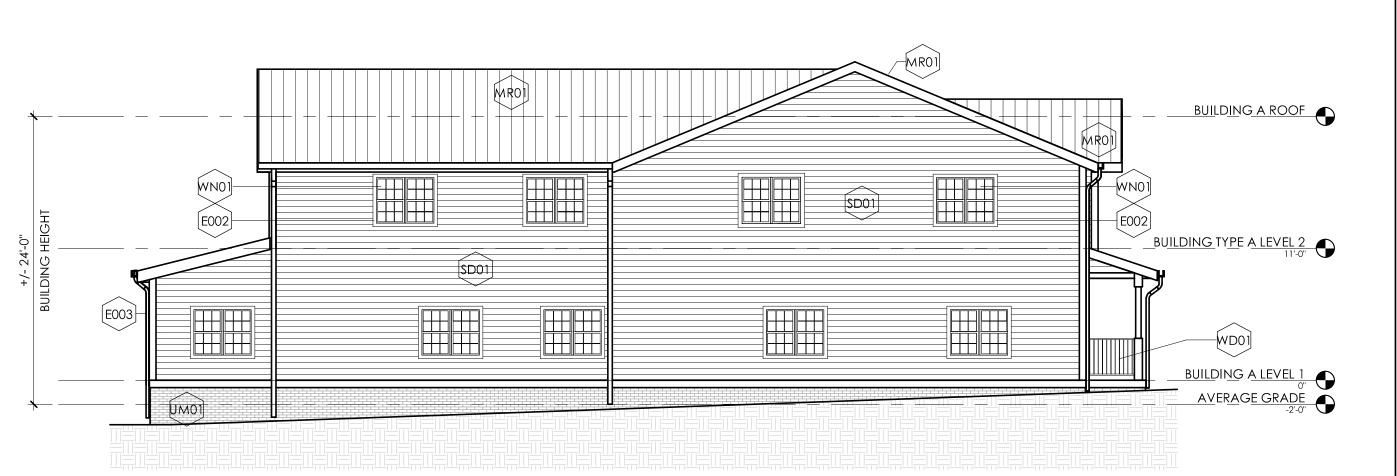
BUILDING TYPE A - ELEVATION 3
1/8" = 1'-0"



BUILDING TYPE A - ELEVATION 2

1/8" = 1'-0"

2



BUILDING TYPE A - ELEVATION 1
1/8" = 1'-0"

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DESCRIPTION: SHEET METAL ROOFING SIZE: REFER TO SECTIONS AND ELEVATIONS 07 4646 FIBER-CEMENT SIDING
MATERIAL: FIBER-CEMENT SIDING

COLOR: COLOR 1 STYLE: HORIZONTAL SIDING PANEL NOTE: PRIMARY FIELD SIDING

SHEET NOTES - ELEVATIONS

E002 FIBER CEMENT TRIM FIN. CARPENTRY

E003 PRE-FINISHED METAL GUTTER & DOWNSPOUT

FINISH LEGEND - EXTERIOR MATERIALS

# SHEET NOTES - ELEVATIONS

E001 EMERGENCY LIGHT

07 4646 FIBER-CEMENT SIDING MATERIAL: FIBER-CEMENT SIDING COLOR: COLOR 2 STYLE: SHINGLES

MR01 07 6113 STANDING SEAM METAL ROOFING

04 2000 UNIT MASONRY MATERIAL: CLAY BRICK MASONRY SIZE: MODULAR NOTE: PRIMARY FIELD BRICK

08 5413 FIBERGLASS CLAD WD. WINDOW NAME: ANDERSEN A-SERIES DESCRIPTION: FIBERGLASS AND WOOD WINDOW MANUFACTURER: ANDERSEN

WD01 06 20 13 WOOD, EXT. FINISH CARPENTRY NAME: PAINTED WOOD DESCRIPTION: POST AND RAIL

DR01 08 11 13 HOLLOW METAL DOOR MATERIAL: HOLLOW METAIL FRAME AND DOOR

SFO1 07 42 93 HARDIE SOFFIT MATERIAL: HARDIE PERFORATED SOFFIT PANEL

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SHEET NAME: **BUILDING TYPE A ELEVATIONS** 

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**AR104** 





BUILDING TYPE B - ELEVATION 4
1/8" = 1'-0"





BUILDING TYPE B - ELEVATION 2

1/8" = 1'-0"



BUILDING TYPE B - ELEVATION 1
1/8" = 1'-0"

PLANNING STAFF. DRAINAGE DESIGN. BUILDINGS & ADJACENT RESIDENTIAL NEIGHBORHOODS. SHEET NOTES - ELEVATIONS # SHEET NOTES - ELEVATIONS E001 EMERGENCY LIGHT E003 PRE-FINISHED METAL GUTTER & DOWNSPOUT DESCRIPTION: SHEET METAL ROOFING SIZE: REFER TO SECTIONS AND ELEVATIONS COLOR: COLOR 2 STYLE: SHINGLES

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E002 FIBER CEMENT TRIM FIN. CARPENTRY

FINISH LEGEND - EXTERIOR MATERIALS

MR01 07 6113 STANDING SEAM METAL ROOFING

**07 4646 FIBER-CEMENT SIDING**MATERIAL: FIBER-CEMENT SIDING

COLOR: COLOR 1 STYLE: VERTICAL SIDING PANEL NOTE: PRIMARY FIELD SIDING

**07 4646 FIBER-CEMENT SIDING**MATERIAL: FIBER-CEMENT SIDING

UM01 04 2000 UNIT MASONRY MATERIAL: CLAY MASONRY UNIT SIZE: MODULAR UNIT NOTE: PRIMARY FIELD BRICK



08 5413 FIBERGLASS CLAD WD. WINDOW NAME: ANDERSEN A-SERIES DESCRIPTION: FIBERGLASS AND WOOD

WD01 06 20 13 WOOD, EXT. FINISH CARPENTRY NAME: PAINTED WOOD DESCRIPTION: POST AND RAIL

MANUFACTURER: ANDERSEN

DR01 08 11 13 HOLLOW METAL DOOR MATERIAL: HOLLOW METAIL FRAME AND

SF01 07 42 93 HARDIE SOFFIT MATERIAL: HARDIE PERFORATED SOFFIT SHEET NAME: **BUILDING TYPE B ELEVATIONS** 

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